)VEMENTS

CITY OF MANDAN, NORTH DAKOTA

MANDAN CITY COMMISSION

ARLYN VAN BEEK

COMMISSIONERS: MIKE BRAUN

SHAUNA LABER DENNIS ROHR SANDRA TIBKE

308 1ST STREET NW MANDAN, ND 58554 GAS:
MONTANA-DAKOTA UTILITIES CO. CITY OF MANDAN

PH: 701-663-8713

PH: 406-359-7223 BISMARCK, ND 58503 CEITH SEIFERT WILLISTON BASIN PIPELINE 250 WEST CENTURY AVENUE

MOR-GRAN-SOU ELECTRIC 2816 367TH ST. NW ELECTRIC:

MANDAN, ND 58554

701-663-0297


411 6TH AVENUE SW MANDAN. ND 58554 PH: 701-667-3240 PUBLIC WORKS DEPARTMENT JEFF WRIGHT

MANDAN, ND 58554 PH: 701-222-6820 1101 16TH STREET NE

719 MEMORIAL HIGHWAY BISMARCK, ND 58501 MIDCONTINENT COMMUNICATIONS

CENTURYLINK PHONE:

AVENUE SE

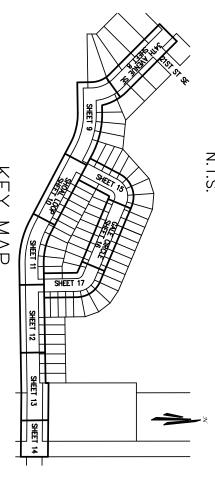

THE EXISTENCE AND LOCATION OF ANY UNDERGROUND UTILITIES, PIPES, AND/OR STRUCTURES SHOWN ON THESE PLANS WERE OBTAINED BY A SEARCH OF AVAILABLE RECORDS. THERE MAYBE EXISTING UTILITIES NOT SHOWN ON THESE PLANS. THE CONTRACTOR SHALL ASCERTAIN THE TRUE VERTICAL AND HORIZONTAL LOCATION OF THOSE UNDERGROUND UTILITIES TO BE USED PRIOR TO CONSTRUCTION AND SHALL BE RESPONSIBLE FOR ANY DAMAGE TO ANY PUBLIC OR PRIVATE UTILITIES, SHOWN OR

NOTE

CONTRACTOR:

JNAUTHORIZED CHANGES

YEY MAP

SCALE: 1"=500'

BEARINGS BASED ON THE EAST LINE OF SECTION TOWNSHIP 138 NORTH, RANGE 81 WEST OF THE 5 PRINCIPAL MERIDIAN AS SOUTH 00'03'48" EAST ACCORDING TO THE PLAT OF LAKEWOOD SIXTH ADDITION, BETWEEN MONUMENTS SHOWN HEREON.

THE ENGINEER PREPARING THESE PLANS WILL NOT BE RESPONSIBLE FOR, OR LIABLE FOR, UNAUTHORIZED CHANGES TO OR USES OF THESE PLANS. ALL CHANGES OF THESE PLANS MUST BE IN WRITING AND MUST BE APPROVED BY THE PREPARER OF THESE PLANS PRIOR TO CONSTRUCTION. CONSTRUCTION CONTRACTOR AGREES THAT IN ACCORDANCE WITH GENERALLY ACCEPTED CONSTRUCTION PRACTICES, CONSTRUCTION CONTRACTOR WILL BE REQUIRED TO ASSUME SOLE AND COMPLETE RESPONSIBILITY FOR JOB SITE CONDITIONS DURING THE COURSE OF CONSTRUCTION OF THE PROJECT, INCLUDING SAFETY OF ALL PERSONS AND PROPERTY, THAT THIS REQUIREMENT SHALL BE MADE TO APPLY CONTINUOUSLY AND NOT BE LIMITED TO NORMAL WORKING HOURS, AND CONSTRUCTION CONTRACTOR FURTHER AGREES TO DEFEND, INDEMNIFY AND HOLD DESIGN PROFESSIONAL HARMLESS FROM ANY AND ALL LIABILITY, REAL OR ALLEGED, IN

NGS BENCHMARK C16 RESET, A DISK SET TOP OF ABUTMENT FOR BRIDGE OVER MISSOURI RIVER LAT: 46°49'03" LONG: 100°49'47", NGVD 29 ELEVATION 1693.67 BENCH MARK:

Z

Administrative

ΈX 9 SHE <u>S</u>

RM 07/14/15

BY DATE

COVER SHEET

GALE LOOP TO GALE CIRCLE

REVISIONS

- LEGEND & QUANTITIES

765432

- WATER & SANITARY SEWER DETAILS
 34TH AVE SE WATER & SANITARY PLAN
- SHOAL LOOP WATER & SANITARY PLAN PROFILE STA 33+80-38+50
- SHOAL LOOP WATER & SANITARY PLAN PROFILE 3+50-7+00 PROFILE 0+50-3+50

10

- SHOAL LOOP WATER & SANITARY PLAN
- SHOAL LOOP WATER & SANITARY PLAN PROFILE 7+00-10+50 જ્ જ્
- SHOAL LOOP WATER & SANITARY PLAN PROFILE 14+00-17+50 SHOAL LOOP WATER & SANITARY PLAN PROFILE 10+50-14+00 ģ

13

12

- PROFILE 17+50-18+98 જ્ર
- GALE CIRCLE WATER & SANITARY PLAN PROFILE 0+00-3+50 GALE CIRCLE WATER & SANITARY PLAN જ્ ૦૦

6

PROFILE 3+50—7+00

15

PROFILE 7+00+10+71 GALE CIRCLE WATER & SANITARY PLAN



PREPARED UNDER THE SUPERVISION OF TAIT & ASSOCIATES, INC.

800.795.0555

and the original document is stored PE-2610, on 07/14/15 Registration Number issued and sealed by James Martin, the City of Mandan This document originally

DRAWN: JN DATE: 05/03/2015 CHECKED: JM DATE: 06/04/2015 REVISION #: 1 JOB NO: ND10090

COVER SHEET LAKEWOOD 8TH ADDITION AXIEN ENGINEERING MORTON COUNTY MANDAN, NORTH DAKOTA

TAIT Since 1964

2911 N 14th Street, Suite 301, Bismarck, ND 58501 p: 701/258/6397

f: 701/353/5798

જ્

ģ

This document originally issued and sealed by James Martin, Registration Number PE-2610, on 07/14/15 and the original document is stored at the City of Mandan Administrative Office.						
PREPARED UNDER THE SUPERVISION OF TAIT & ASSOCIATES, INC.			WATER SERVICE	WS		
			W/WTR WATER	W/		
			TYPICAL	AA.L		
			V TOP OF WATER	MOL	EXISTING COMMUNICATIONS VAULT	0
			SS TOP OF SANITARY SEWER	TOSS	PROPOSED FIRE HYDRANT	
				TB	EXISTING FIRE HYDRANT	÷<
			STATION	STA	UFCC7	٥
				WITH THRUST SMH	PROPOSED WATER BEND OR TEE WITH	Ī
				SD	PROPOSED WATER VALVE	⊗ ∑
			SANITARY	S/SS	EXISTING WATER VALVE	
			W RIGHT OF WAY	R/W		
			RADIUS	R	PROPOSED 8" WATER	K
			POLYVINYL CHLORIDE	N PVC	PROPOSED WATER SERVICE PER PLAN	
	300TON	SUBCUT GRAVEL	POINT OF TANGENCY	PT	EXISTING WATER	
	1EA 1EA	DEWATERING	POINT OF CURVATURE		PROPOSED SANITARY SEWER MANHOLE	©
	64EA	8"X4" PVC WYE	LINEAL FEET	ᄃ	EXISTING SANITARY SEWER MANHOLE	(i)
	31LF	6" PVC SANITARY LATERAL		- <u>-</u>	PROPOSED 8" SANITARY SEWER	
	12EA 3118LF	8" PVC SANITARY MAIN		PER PLAN	PROPOSED SANITARY SEWER LATERAL	
	2		GATE VALVE	GV	EXISTING SANITARY SEWER	
		SANITARY SEWER:	GAS/G GAS TRENCH	GA	PROPOSED STORM DRAIN MANHOLE	•
et Suite	300TON	SUBCUT GRAVEL	FINISHED SURFACE	FS		0
	64EA 1FA	CONNECTION DEWATERING	FIRE HYDRANT	꾸	PROPOSED STORM DRAIN INLET	
	C 1	RVICE	EXISTING	EX	PROPOSED STORM DRAIN	SD
	1995LF 645A	SERV	ELEC/E ELECTRIC TRENCH	EL	EXIMING WICKM DRAIN	
	5EA	GATE VALVE &	EACH	EA	TYPHING STORY DRAIN	7
	7EA	6" GATE VALVE & BOX	CENTERLINE	CL	SLOPE/FLOW DIRECTION	2.0%
	3169LF	PVC WATER	BLOW-OFF V	ВИ	- PROPOSED UTILITY EASEMENT	
	173LF	6" PVC WATER MAIN	BOTTOM OF WATER	BOW	-WAY	
		WATER MAIN.	BOTTOM	BOSD	PROPERTY/LOT LINE	
		QUANTITIES:	BBREVIATIONS:	<u>A</u>		SITE LEGEND:

2

DRAWN: JN
DATE: 05/03/2015
CHECKED: JM
DATE: 06/04/2015
REVISION #: 1
DATE: 06/04/2015
JOB NO: ND10090

LEGEND & QUANTITIES LAKEWOOD 8TH ADDITION AXIEN ENGINEERING MORTON COUNTY MANDAN, NORTH DAKOTA

TAIT
Since 1964

2911 N 14th Street, Suite 301, Bismarck, ND 58501

p: 701/258/6397 f: 701/353/5798 www.fail.com
Los Angeles Rancho Cucamonga Sacramento Seditie North Dakota

NO. DESCRIPTION REVISIONS

BY DATE

- 1. ALL CONSTRUCTION SHALL MEET THE REQUIREMENTS OF THE APPLICABLE LOCAL, STATE AND FEDERAL REGULATIONS; THE CITY OF MANDAN STANDARD SPECIFICATIONS AND DETAILS; AND THE CONSTRUCTION DOCUMENTS THE WATER AND SANITARY SEWER IMPROVEMENTS: SHOAL LOOP, GALE CIRCLE, & 34TH AVENUE SE, DISTRICT 202 PROJECT 2015—12, MANDAN, NORTH DAKOTA. CITY OF MANDAN SPECIFICATIONS AND DETAILS CAN BE FOUND AT http://www.cityofmandan.com. (HOME> CITY DEPARTMENTS> ENGINEERING & PLANNING> ENGINEERING> PROJECTS> CONSTRUCTION SPECIFICATIONS)
- THESE NOTES APPLY TO THE ENTIRE PROJECT EXCEPT AS INDICATED OTHERWISE. CONTRACTOR SHOULD NOTE THAT ADDITIONAL CONSTRUCTION NOTES ARE INCLUDED INDIVIDUAL DRAWINGS. 9
- THESE NOTES ARE FOR GENERAL THE WRITTEN SPECIFICATIONS, DE THE WRITTEN SPECIFICAT DETAILS, ADDENDA AND REFERENCE IN CONJUNCTION WITH AND AS A SUPPLEMENT ETAILS, ADDENDA AND CHANGE ORDERS ASSOCIATED WITH
- REQUESTS AND BY THE CONTRACTOR OR OWNER SHALL BE APPROVED IN WRITING BY THE D CITY PRIOR TO IMPLEMENTATION.
- BROUGHT TO THE ATTENTION OF ANY ERRORS OR OMISSIONS DISCOVERED BY THE CONTRACTOR IN THE PLAN SET SHALL OUGHT TO THE ATTENTION OF THE ENGINEER WHEN DISCOVERED. THE CONTRACTOR SHALL SHALL 먪
- AND ITEMS NOT INCLUDED IN THE PLANS AS A PAY ITEM BUT INCLUDED ELSEWHERE IN THE _ANS SHALL BE PROVIDED BY THE CONTRACTOR AT NO ADDITIONAL COST TO THE OWNER ND SHALL BE CONSIDERED INCIDENTAL ITEMS.
- ON THIS SPECIFIC PROJECT. THIS PLAN SET HAS A LIST OF GENERAL ABBREVIATIONS AND SYMBOLS AND MATERIAL SENDS LISTED ON IT. SOME SYMBOLS, MATERIALS AND ABBREVIATIONS MAY NOT BE UTI UTILIZED
- CONTRACTOR SHALL PROVIDE A ONE (1) WEEK NOTICE TO THE ENGINEER AND MANDAN PRIOR TO BEGINNING ANY CONSTRUCTION.
- NMOHS ENGINEER AND/OR CITY SHALL HAVE THE RIGHT TO REQUIRE ADDITIONAL WORK NOT HEREIN BUT REQUIRED FOR SUCCESSFUL COMPLETION OF THE PROJECT.
- EQUIPMENT NECESSARY AND REQUIRED FOR THE PROPER CONSTRUCTION OF AND TASKS SHALL BE ON THE PROJECT IN FIRST-CLASS WORKING CONDITION CONSTRUCTION IS PERMITTED TO START. 유 PROJECT
- 300 TONS OF "SUBCUT GRAVEL' HAS BEEN INCLUDED IN PLAN QUANTITIES FOR SANITARY AND "SUBCUT GRAVEL" MAY OR MAY NOT BE USED DEPENDING ON SITE SOIL CONDITIONS
- AND WITH THE CONTRACTOR IS TO PROVIDE AND MAINTAIN ADEQUATE DEWATERING EQUIPMENT TO REMOVE D DISPOSE OF ANY SURFACE AND GROUNDWATER ENTERING TRENCHING. ALL COSTS ASSOCIATED IN WELLPOINT DEWATERING, AND OTHER PUMP SYSTEMS, SHALL BE CONSIDERED INCIDENTAL TO THE NITRACT. PERMITS REQUIRED FOR DEWATERING SHALL BE OBTAINED BY THE CONTRACTOR.

PROTECTION OF EXISTING FEATURES AND REMOVAL NOTES:

- COMPANIES ARE INCIDENTAL TO OTHER BID ITEMS. NOT BEEN INDEPENDENTLY VERIFIED BY THE OWNER OR IT'S REPRESENTATIVES. THE CONTRACTOR SHALL DETERMINE THE EXACT LOCATION OF ALL EXISTING UTILITIES BEFORE COMMENCING WORK. UNDERGROUND LOCATES MAY BE MADE USING THE "ONE CALL" NUMBER, 811 OR 1—800—795—0555. LOCATION OF EXISTING UTILITIES AND COORDINATION WITH UTILITY 13. THE LOCATION OF EXISTING UNDERGROUND UTILITIES SHOWN ARE APPROXIMATE AND HAVE
- 14. WHERE EXISTING UTILITY WIRES (TELEPHONE, ELECTRIC) ARE LOCATED ADJACENT TO OR ABOVE THE PROPOSED IMPROVEMENTS, THE CONTRACTOR SHALL TEMPORARILY SUPPORT EXISTING WIRES AND INSTALL IMPROVEMENTS UNDER EXISTING WIRES. ANY DECISION TO HAVE THE EXISTING UTILITIES MOVED WILL BE AT THE CONTRACTORS EXPENSE.
- 15. THE CONTRACTOR SHALL PROTECT ALL SURVEY MONUMENTS. MONUMENTS DISTURBED DESTROYED SHALL BE REPLACED BY THE OWNER'S REPRESENTATIVE AT THE CONTRACTOR MENTS DISTURBED OR THE CONTRACTOR'S
- AND 16. MISCELLANEOUS ITEMS SUCH AS AND NOT LIMITED TO: MAILBOXES, STREET LIGHTS, TRAFFIC LIGHTS, SIGNS, FENCES, POLES, ETC. SHALL BE PROTECTED OR REMOVED AND REINSTALLED BY THE CONTRACTOR WITH THE OWNER'S AND PROPERTY OWNER'S PERMISSION, WORK SHALL BE INCIDENTAL TO THE CONTRACT. O
- 17. ANY EXISTING STRUCTURES DISTURBED BY CONSTRUCTION ARE TO BE RESTORED ORIGINAL LOCATION AND CONDITION. ALL STRUCTURES SUCH AS CURB AND GUTTER, (AND BITUMINOUS SIDEWALKS, PAVING BRICKS, FENCING, RETAINING WALLS, ETC., CROSTHE PROPOSED WATER, SEWER, CULVERTS AND ROADWAYS MAY NOT BE INDICATED. AND GUTTER, CONC LLS, ETC., CROSSED , CONCRETE OSSED BY THEIR
- OTHER ITEMS THE OWNER DOES NOT WISH TO SALVAGE SHALL BECOME THE CONTRACTOR'S PROPERTY AND SHALL BE REMOVED FROM THE SITE AND DISPOSED OF PROPERLY, INCIDENTAL TO THE CONTRACT. ASPHALT AND CONCRETE SHALL BE DISPOSED OF OFFSITE AT A LICENSED LANDFILL INCIDENTAL TO THE CONTRACT.
- R TO REMOVAL ΑL

- 20. ALL UTILITY TRENCHES SHOWN ON THE PLANS. ARE ТО BE BACKFILLED & COMPACTED TO THE PROPOSED SUBGRADE S
- 21. ALL DISTURBED AREAS OUTSIDE OF THE RIGHT OF WAY AND WITHIN THE PROJECT BOUNDARY SHALL BE SEEDED AND MULCHED. SEEDING & MULCHING TO BE INCIDENTAL TO CONTRACT. SEED SHALL BE CLASS I, AS DEFINED IN CITY OF MANDAN CONSTRUCTION SPECIFICATIONS—SECTION 1202—1. MULCHING SHALL BE HAY, AS DEFINED IN CITY OF MANDAN CONSTRUCTION SPECIFICATIONS—SECTION 1204—2. HAY MULCH SHALL BE ANCHORED MECHANICALLY.
- THE CONTRACTOR SHALL PROVIDE METHODS AND MEANS TO OBTAIN THE REQUIRED COMPACTION PIPE BED AND THE BACKFILL, AS SPECIFIED.

23. EXCAVATION:

- 23.1. EXCAVATION SHALL BE PERFORMED AS INDICATED ON THE CONTRACT PLANS TO THE LINES, GRADES, AND ELEVATION SHOWN OR AS DIRECTED BY THE ENGINEER, AND SHALL BE MADE SO THAT THE REQUIREMENTS FOR FORMATION OF EMBANKWENTS CAN BE FOLLOWED. NO EXCAVATION OR STRIPPING SHALL BE STARTED UNTIL THE ENGINEER HAS STAKED OUT THE PROPOSED WORK. ALL MATERIAL ENCOUNTERED WITHIN THE LIMITS INDICATED SHALL BE REMOVED AND DISPOSED OF AS DIRECTED. DURING THE PROCESS OF EXCAVATION, THE GRADE SHALL BE MAINTAINED SO THAT IT WILL BE WELL DRAINED AT ALL TIMES. WHEN DIRECTED, TEMPORARY DRAINS AND DRAINAGE DITCHES SHALL BE INSTALLED TO INTERCEPT OR DIVERT SURFACE WATER WHICH MAY AFFECT WORK.
- 23.2. THE CONTRACTOR SHALL MAKE THE DISTRIBUTION AS INDICATED ON THE PLANS. WIDENING OF NARROWING OF THE SECTION AND RAISING OR LOWERING OF THE GRADE TO AVOID HAUL WILL NOT BE PERMITED. THE ENGINEER RESERVES THE RIGHT TO MAKE MINOR ADJUSTMENTS OR REVISIONS IN LINES OR GRADES, IF FOUND NECESSARY, AS THE WORK PROGRESSES DUE TO DISCREPANCIES IN THE PLANS OR TO OBTAIN SATISFACTORY CONSTRUCTION. z
- 23.3. ALL VEGETATION SUCH AS BRUSH, HEAVY SODS, HEAVY GROWTH OF GRASS, DECAYED VEGETABLE MATTER, RUBBISH, AND ANY OTHER UNSUITABLE MATERIAL WITHIN THE AREA UPON WHICH EMBANKMENT IS TO BE PLACED SHALL BE STRIPPED OR OTHERWISE REMOVED BEFORE THE EMBANKMENT IS TARRIED, AND IN NO CASE SHALL SUCH OBJECTIONABLE MATERIAL BE ALLOWED UNDER THE EMBANKMENT.
- 23.4. EMBANKMENTS SHALL BE FORMED OF SATISFACTORY MATERIALS PLACED IN SUCCESSIVE HORIZONTAL LAYERS OF NOT MORE THAN 8 INCHES IN LOOSE DEPTH FOR THE FULL WIDTH OF THE
- ALL MATERIALS PLACED IN T ER SUCH AS LEAVES, GRASS, THE EMBANKMENT SHALL S, ROOTS, AND OTHER OB ALL BE REASONABLY FREE OF OBJECTIONABLE MATERIAL.
- WATER FOR COMPACTING SUBGRADE OR GRAVEL BASE SHALL BE INCIDENTAL TO OTHER BID ITEMS.

24.

- 25. COMPACTION REQUIREMENT OF SUBGRADE SHALL COMPLY WITH SECTION 200 OF MANDAN STANDARD CONSTRUCTION SPECIFICATIONS. THE CITY OF

WATER MAIN NOTES

- 26. WATER MAIN TO BE 8"PVC C-900, PC235 (DR18) PIPE. MARKING TAPE SHALL BE INSTALLED MAIN IN ACCORDANCE WITH CITY OF MANDAN SPECIFICATIONS FOR WATER DISTRIBUTION. Ν, ABOVE ≓
- 27. WATER SERVICES TO BE 1" COPPER, TYPE-K PIPE OR HIGH-DENSITY PLYETHYLENE (HDPE) PER CIT MANDAN SPECS 1209-2.3 AND 1209-2.4 RESPECTIVELY AS NOTED ON PLANS. WATER SERVICES TO BE EXTENDED WITH APPROPRIATE FITTINGS TO R/W LINE AS SHOWN ON PLANS AND CAPPED AND MARKED ACCORDANCE WITH CITY OF MANDAN STANDARD SPECIFICATIONS FOR WATER SERVICE CONNECTIONS. ΥHO 略 ≦ ‡ 유
- $27.1.\ \mbox{FOR}$ ALL 1" WATER SERVICES INSTALL PER DETAIL ON SHEET 5.
- FINISHED SURFACE AND MINIMUM 10' HORIZONTAL SEPARATION FROM OUTSIDE WALLS TO 8"PVC SANITARY SEWER MAIN. ENSURE WATER MAINTAINS MINIMUM 1.5' VERTICAL SEPARATION FROM ALL SANITARY SEWER LATERALS AT 28. CONTRACTOR TO ENSURE WATER MAIN MAINTAINS A MINIMUM OF 7.5' VERTICAL DEPTH BELOW PROPOSED
- 29. ALL DIMENSIONS AND OFFSETS ARE FROM STREET CENTERLINE TO CENTERLINE OF WATER MAIN UNLESS
- 30. CONTRACTOR TO INSTALL 6" FIRE HYDRANTS PER DETAIL SHOWN HERE SPECIFICATIONS FOR WATER DISTRIBUTION. PROVIDE 8"X8"X6" TEE WITH 6" 6"PVC C-900, PC235 (DR18) FIRE HYDRANT LINE TO 8" PVC WATER MAIN. SHOWN HEREIN AND CITY OF MANDAN TEE WITH 6" GATE VALVE FOR CONNECTION 유
- 31. ALL DETAILS. ALL PIPE TRENCHING AND BEDDING SHALL CONFORM TO CITY OF MANDAN SPECIFICATIONS AND
- 32. ALL BENDS, G GATE SPECIFICATIONS FOR WATER DISTRIBUTION. VALVES, TEES, AND CONNECTIONS SHALL BE RESTRAINED AND BRACED ALL MUST BE SIZED ACCORDING TO PLAN.
- GATE VALVES ARE TO BE INSTALLED 3'-5' FROM TEES AS SHOWN ON PLANS.

33.

- 34. CONNE PROVIDED MANDAN SPECIFICATIONS FOR WATER SERVICE CONNECTIONS. CONNECTION OF PROPOSED 8" PVC WATER MAIN BE CONNECTED WITH A TAPPING SLEEVE TO EXISTING 8" PVC WATER MAIN AND TAPPING VALVE Z ACCORDANCE ≦ ‡ \overline{S} IS NOT 유
- 35. HORIZONTAL AND VERTICAL DEFLECTIONS AS SHOWN ON PLANS ARE TO BE ACHIEVED WIT DEFLECTION THROUGH THE LENGTH OF THE PIPE. PIPES SHALL BE DEFLECTED TO A MINIMUM 200' AS NECESSARY. THERE SHALL BE NO DEFLECTION AT JOINTS/CONNECTIONS. WITH RADIAL

36. ACCORDANCE WITH CITY OF MANDAN SPECIFICATIONS FOR SEWERS SANITARY SEWER MAIN TO (SDR 35) PIPE. MARKING TAPE SHALL BE INSTALLED 2' ABOVE THE MAIN

RM 07/14/1

BY DATE

- 37. SANITARY SEWER LATERALS ARE TO BE 4" PVC (SDR 35) PIPE UNLESS OTHERWSE NOTED ON THE PLANS. LATERALS ARE TO BE CONNECTED TO THE 8" SS MAIN WITH AN 8"x4" WYE UNLESS CONNECTED DIRECTLY INTO A MANHOLE STRUCTURE. REFER TO STANDARD DETAILS HEREIN. SANITARY LATERALS TO BE EXTENDED TO R/W LINE AS SHOWN ON PLANS AND CAPPED AND MARKED WITH POST IN ACCORDANCE WITH CITY OF MANDAN STANDARD SPECIFICATIONS FOR SANITARY SEWER CONNECTIONS.
- ALL PIPE TRENCHING AND BEDDING SH ALL CONFORM TO CITY OF MANDAN SPECIFICATIONS AND STANDARD DETAILS.

GALE LOOP TO GALE CIRCLE

REVISIONS

38.

- 39. SANITARY SEWER MANHOLES ARE TO STEPS SHALL NOT BE PROVIDED UNLESS BE 48" WITH ECCENTRIC CONES PER CITY OF MANDAN STANDARD DETAIL
- 40. CONTRACTOR SHALL TELEVISE SANITARY SEWER MAINS PER CITY OF MANDAN SPEC 801-3.9

TRAFFIC CONTROL AND SIGNAGE

- 41. CONTRACTOR SHALL SUBMIT A TRATRAFFIC CONTROL PLAN PREPERATION FIC CONTROL PLAN TO ENGINEER PRIOR TO BEGINNING WORK. COST FOR SHALL BE INCIDENTAL TO THE CONTRACT.
- CONTRACTOR SHALL COORDINATE DE THE CITY OF MANDAN ENGINEERING DETOURS TO A MINIMUM. 42. CONTRACTOR SHALL MAINTAIN INGR DETOL PEF ESS/EGRESS ACCESS TO INDIVIDUAL PROPERTY OWNERS AT ALL TIMES. JRS AND ANY TEMPORARY CLOSURES WITH EACH PROPERTY OWNER AN VARTMENT. CONTRACTOR SHALL KEEP DURATION OF ALL CLOSURES AND AND
- 43. CONTRACTOR SHALL MAINTAIN TEMF PORARY DETOUR ROADS UNTIL DETOUR IS NO LONGER NECESSARY NTAL TO THE CONTRACT.
- CONTRACTOR SHALL FOLLOW TRAFFIC CONTROL FOR STREET AND HIGHWAY CONSTRUCTION. IANUAL ON UNIFORM TRAFFIC CONTROL DEVICES (MUTCD) STANDARDS AND

44.

CONTRACTOR SHALL FOLLOW N CONTROL VORTH DAKOTA DEPARTMENT OF TRANSPORTATION STANDARD DRAWINGS OL DEVICES.

STORM WATER POLLUTION PREVENTION

- 46. THE CONTRACTOR SHALL BE RESPO DAKOTA DEPARTMENT OF HEALTH. AN REQUIREMENTS MAY BE ACQUIRED BY 0.701-328-5210. CONTRACTOR SHALL A EROSION CONTROL MEASURES AND INS' INST ONSIBLE FOR OBTAINING A GENERAL PERMIT (NPDES) FROM THE NORTH APPLICATION PACKAGE WITH ALL RELATED AND SUBSEQUENT CONTACTING THE NORTH DAKOTA DEPARTMENT OF HEALTH AT GENERAL PERMIT. MAINTENANCE OF THE NPDES PERMIT. MAINTENANCE OF TALLATION OF ADDITIONAL MEASURES SHALL BE INCIDENTAL TO THE WORK
- 47. THE CONTRACTOR IS RESPONSIBLE PROPERTIES AND ROADWAYS. TRACKING FOR MINIMIZING TRACKING OF SOIL AND DEBRIS ONTO ADJACENT MUST BE REMOVED BY THE END OF EACH DAY.
- 48. THE CONTRACTOR SHALL BE REQUIRED TO CLEAN STREETS THEY WERE IN PRIOR TO THE START OF CONSTRUCTION BEFORE ED TO CLEAN STREETS AND SIDEWALKS AND REPAIR CONSTRUCTION BEFORE OPENING UP TO TRAFFIC. TO THE CONDITION
- 49. THE CONTRACTOR SHALL INSTALL IDENTIFY THE CONCRETE WASHOUT AR WATER FROM FLOWING TO THE STORM A CENTRAL CONCRETE WASHOUT LOCATION AND PROVIDE A SIGN TO EA. THE CONTRACTOR SHALL CONSTRUCT A PIT TO PREVENT WASHOUT WATER COLLECTION SYSTEM.
- 50. EROSION CONTROL PLAN AND BMP SELECTION:
- DAYS SHALL BE STABILIZED TO MINI
 CONSTRUCTION IS PROHIBITIVE DUE
 ACCOMPLISHED BY MULCHING/CRIMF CONTROL SHALL BE ACHIEVED BY F CONTRACTOR IS RESPONSIBLE TRACKING MUST BE REMOVED 50.1. AREAS NOT BEING DEVELOPEC DAYS SHALL BE STABILIZED TO MIN O OR PLANNED TO BE DEVELOPED FOR A PERIOD OF GREATER THAN 60 IMNIZE WIND AND WATER EROSION. THIS INCLUDES THOSE MONTHS WHEN TO THE WINTER SEASON. WIND EROSION PROTECTION SHOULD BE SINCE WITH 70% VEGETATION IS ESTABLISHED. PERMANENT EROSION PERMANENT SEEDING OF SLOPES, DISTURBED DITCH SECTIONS AND MIX SHALL BE A SUSTAINABLE PERENNIAL VARIETY. FURTHER, THE ALL CLEAN-UP RESULTING FROM SITE EROSION AND SOIL TRACKING. HE END OF EACH WORK DAY
- 50.2. EROSION CONTROL STRUCTURES SHALL BE IN PLACE PRIOR TO ANY LAND-DISTURBING ACTIVITIES, AND WILL BE INSTALLED BY CONTRACTOR, HOWEVER ADDITIONAL EROSION CONTROL MEASURES MAY BE NECESSARY. ADDITIONAL EROSION CONTROL MEASURES TO BE INCIDENTAL TO THE CONTRACT. THE CONTRACTOR WILL NOTIFY THE ENGINEER AND THE CITY ENGINEERING DEPARTMENT, ONCE EROSION CONTROLS ARE INSTALLED, FOR REVIEW MAINTAINING EROSION CONTROL STRUCTURES, SITE CLEAN-UP AND, RE-EVALUATION OF THE EROSION CONTROL PLAN SHALL BE DONE ON A PREPARED LINDER THE PREPARED UNDER THE SUPERVISION OF TAIT & ASSOCIATES, INC.
- SILT FENCE AND FIBER CONTRACT VEGETATION IS ROLLS SHALL BE REMOVED BY THE ESTABLISHED, IF INSTALLED

. ≅

WHEN

and the original PE-2610, on 07/14/15 Registration Number James Martin, ssued and sealed by This document originally

GENERAL NOTES

LAKEWOOD 8TH ADDITION AXIEN ENGINEERING MORTON COUNTY MANDAN, NORTH DAKOTA

TAIT Since 1964

2911 N 14th Street, Suite 301, Bismarck, ND 58501 p: 701/258/6397

f: 701/353/5798

DRAWN: TU DATE: 05/03/2015 CHECKED: JM DATE: 07/02/2015 REVISION #: 3 JOB NO: ND10090


Administrative

Office.

ယ

document is stored

the City of Mandan

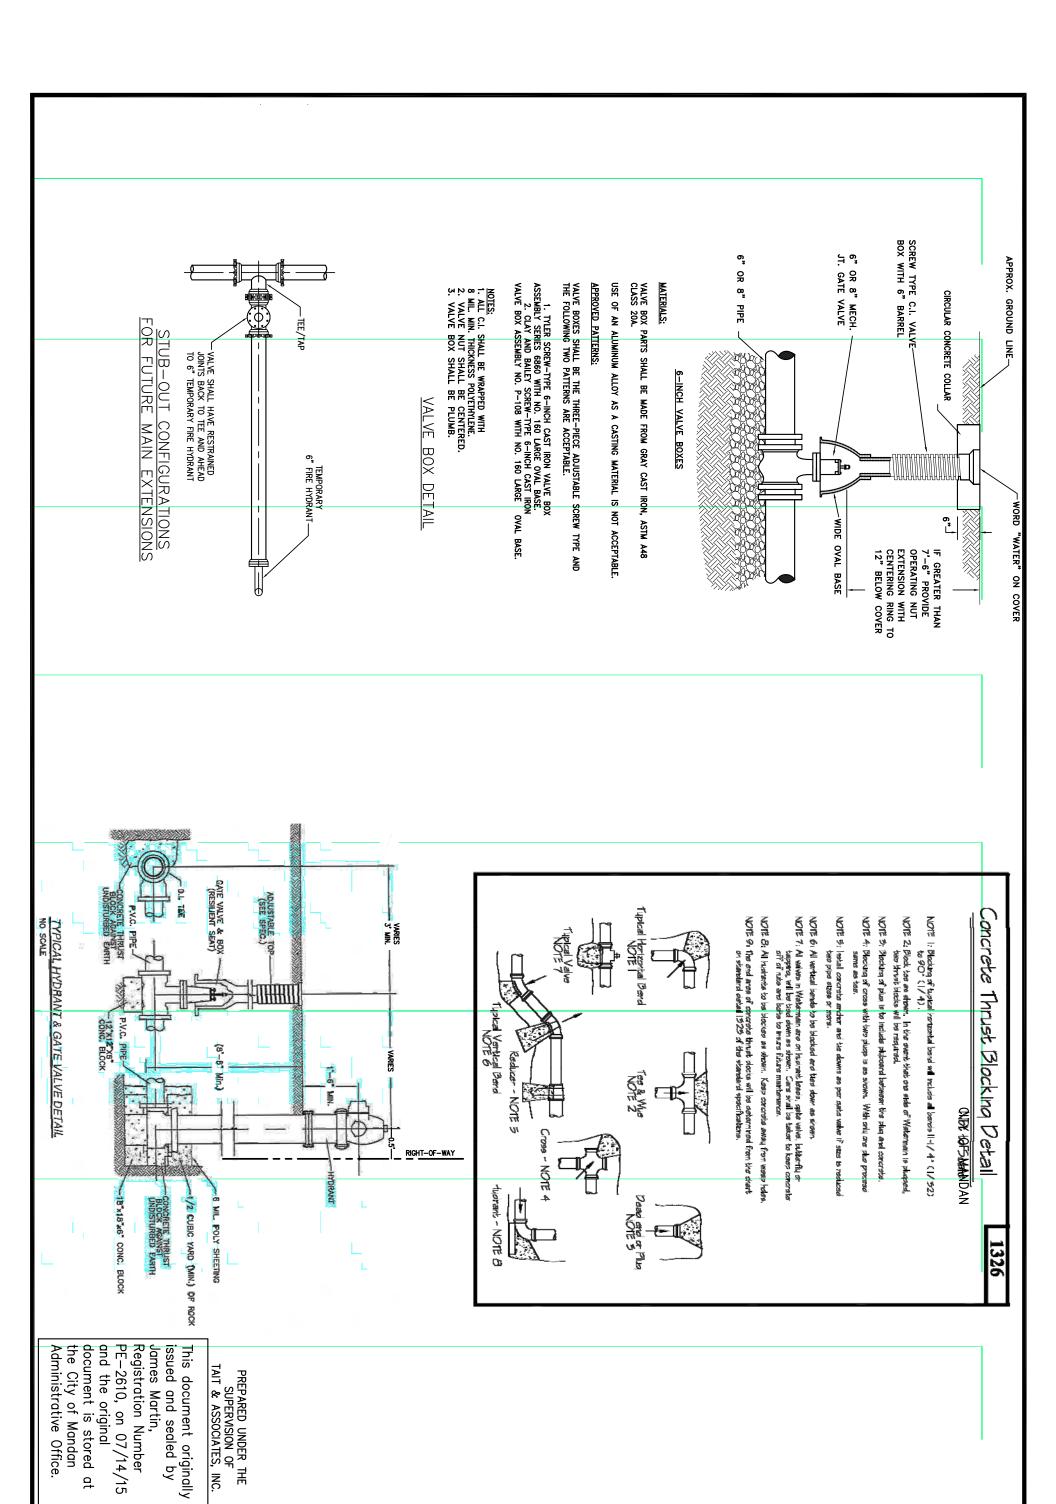

Registration Number issued and sealed by James Martin, DRAWN: JN DATE: 05/03/2015 CHECKED: JM DATE: 06/04/2015 REVISION #: 1

DATE: 06/04/2015

JOB NO: ND10090

WATER & SANITARY SEWER DETAILS

LAKEWOOD 8TH ADDITION AXIEN ENGINEERING MORTON COUNTY MANDAN, NORTH DAKOTA

TAIT Since 1964

2911 N 14th Street, Suite 301, Bismarck, ND 58501 p: 701/258/6397 www.tait.com f: 701/353/5798

BY DATE REVISIONS


4




Phone: 800-EJP-24HR (357-2447) • Fax: 207-582-5637

Hydrants D-2

WB-67-250 Waterous Pacer

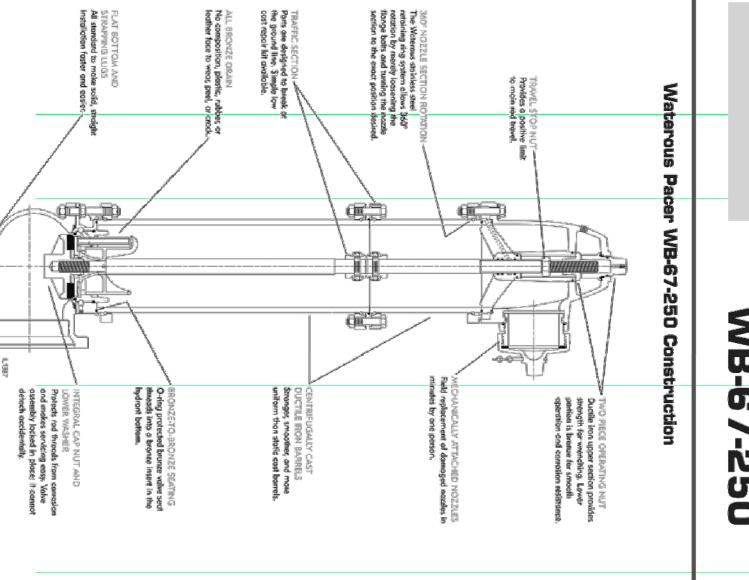

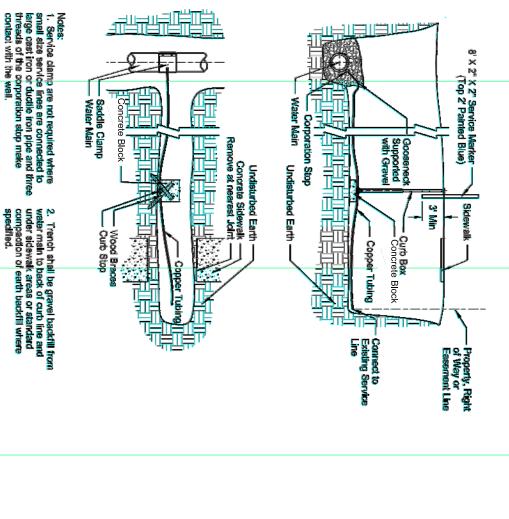

WATER CURB CONNECTION

Actual location *Curb Stop Note:

of curb stop to be located 1' inside street side edge of sidewalk

Trench shall be gravel backfill from water main to back of curb line and under sidewalk areas or standard compaction of earth backfill where specified.

Grade Line Slide Type Curb Box

Corporation Stop PVC Water Main

Copper Service Line Diameter Varies

Bolts to be Tightened – o Manfacturer's Specs. with Torque Wrench

PREPARED UNDER THE SUPERVISION OF TAIT & ASSOCIATES, INC.

TYPICAL CORPORATION STOP AND CURB STOP

and the original document is stored at PE-2610, on 07/14/15 Registration Number issued and sealed by James Martin, This document originally

WATER & SANITARY SEWER DETAILS

LAKEWOOD 8TH ADDITION AXIEN ENGINEERING MORTON COUNTY MANDAN, NORTH DAKOTA

TAIT Since 1964

2911 N 14th Street, Suite 301, Bismarck, ND 58501 p: 701/258/6397 www.tait.com f: 701/353/5798


BY DATE REVISIONS

S

Administrative the City of Mandan

Office.

DRAWN: JN DATE: 05/03/2015 CHECKED: JM DATE: 06/04/2015 REVISION #: 1 DATE: 06/04/2015 JOB NO: ND10090

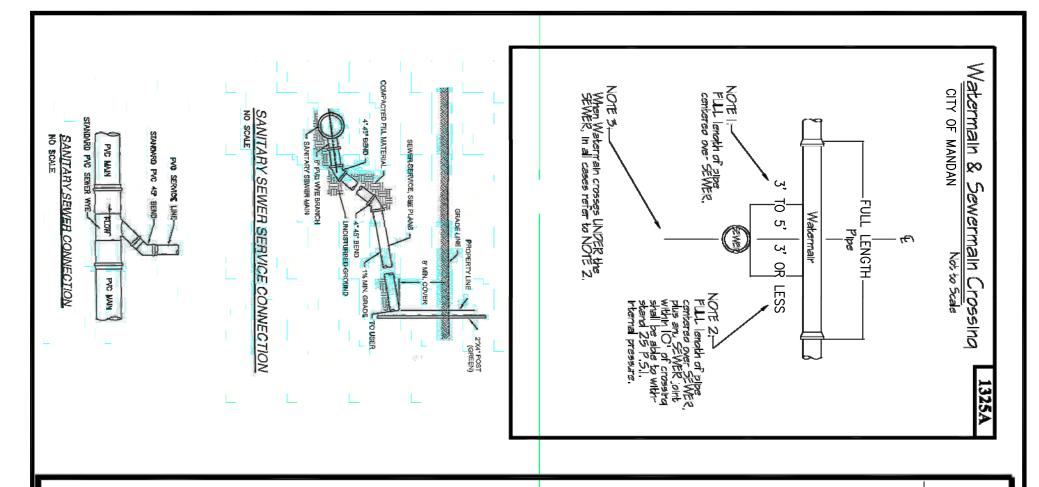

NOTE NO.5

CAST IN PLACE MANHOLI

E BASE

NOTE NO.6



Not to Scale

CITY OF MANDAN

NOTE NO.3 - CRETEX P2 GASKETED JOINT FOR 48" MANHOLES, CRETEX CX-4 JOINT FOR ALL OTHER SIZES OF MANHOLES OR EXTERIOR SEAL BY PRESS-SEAL GASKET CORP. EZ WRAP AND EZ STIK NO. 4 PRIMER, CRETEX SPECIALTY PRODUCTS "MAC WRAP", OR AN APPROVED EQUAL. NOTE NO.2 - ALLOWANCE FOR ADJUSTMENT - 9" TO 6" - SEE STANDARD DETAIL NO. 1314 . NOTE NO.1 - MANHOLE CASTING AND COVER SHALL BE AS DEFINED IN SECTION 1205-2.6

NOTE NO.6 - CAST IN PLACE MANHOLE BASES SHALL BE DIMENSIONED AS SHOWN UNLESS OTHERWISE INDICATED.

BASES SHALL BE REINFORCED WITH NO.4 REBAR SPACED 15" ON CENTER BOTH WAYS.

NOTE NO.8 - STEPS SHALL NOT BE PLACED IN SANITARY SEWER, STORM SEWER OR AIR RELEASE MANHOLES OR SPECIFIED, IF SPECIFIED, THE MANHOLE STEPS SHALL BE DELTA SUREFOOT OR APPROVED EQUAL SPACED 16" ON CENTER. ______NOTE NO.1

NOTE NO.1

NOTE NO.2

5'-10

STEPS SHALL BE

ECIFIED.

6<u>1</u> Z O

4 0

NOTE NO.7

NOTE NO.7 - EXTERNAL MANHOLE CHIMNEY SEAL AS MANUFACTURED BY CRETEX OR AN APPROVED EQUAL, IF SF

NOTE NO.5 - MANHOLE TOP SECTION SHALL BE ECCENTRIC FOR 48" MANHOLES.

NOTE NO.4 - IF PRECAST MANHOLE BASE IS USED, FLOOR SHALL BE GROUTED AND SLOPED, AS SHOWN, FROM 1/2 THE DIAMETER OF THE PIPE. SEE SECTION 1205-2.9 FOR PRECAST MANHOLE BASE REINFORCEMENT.

308A

Registration Number and the original document is stored PE-2610, on 07/14/15 issued and sealed by James Martin, This document originally PREPARED UNDER THE SUPERVISION OF TAIT & ASSOCIATES, INC.

> DRAWN: JN DATE: 05/03/2015 CHECKED: JM DATE: 06/04/2015 REVISION #: 1 DATE: 06/04/2015 JOB NO: ND10090

WATER & SANITARY SEWER DETAILS

NOTE NO.3

PRECAST REINFORCED
 CONCRETE

Ġ

VARIABLE

FLOW

(MINIMUM)

NOTE NO.4

VARIABLE

SECTION B-B

LAKEWOOD 8TH ADDITION AXIEN ENGINEERING MORTON COUNTY MANDAN, NORTH DAKOTA



2911 N 14th Street, Suite 301, Bismarck, ND 58501 p: 701/258/6397 f: 701/353/5798

BY DATE REVISIONS

တ


Administrative the City of Mandan

Office.

(or as Noted in Section 1205-2.9)

5<u>-1</u>0

SECTION A-A

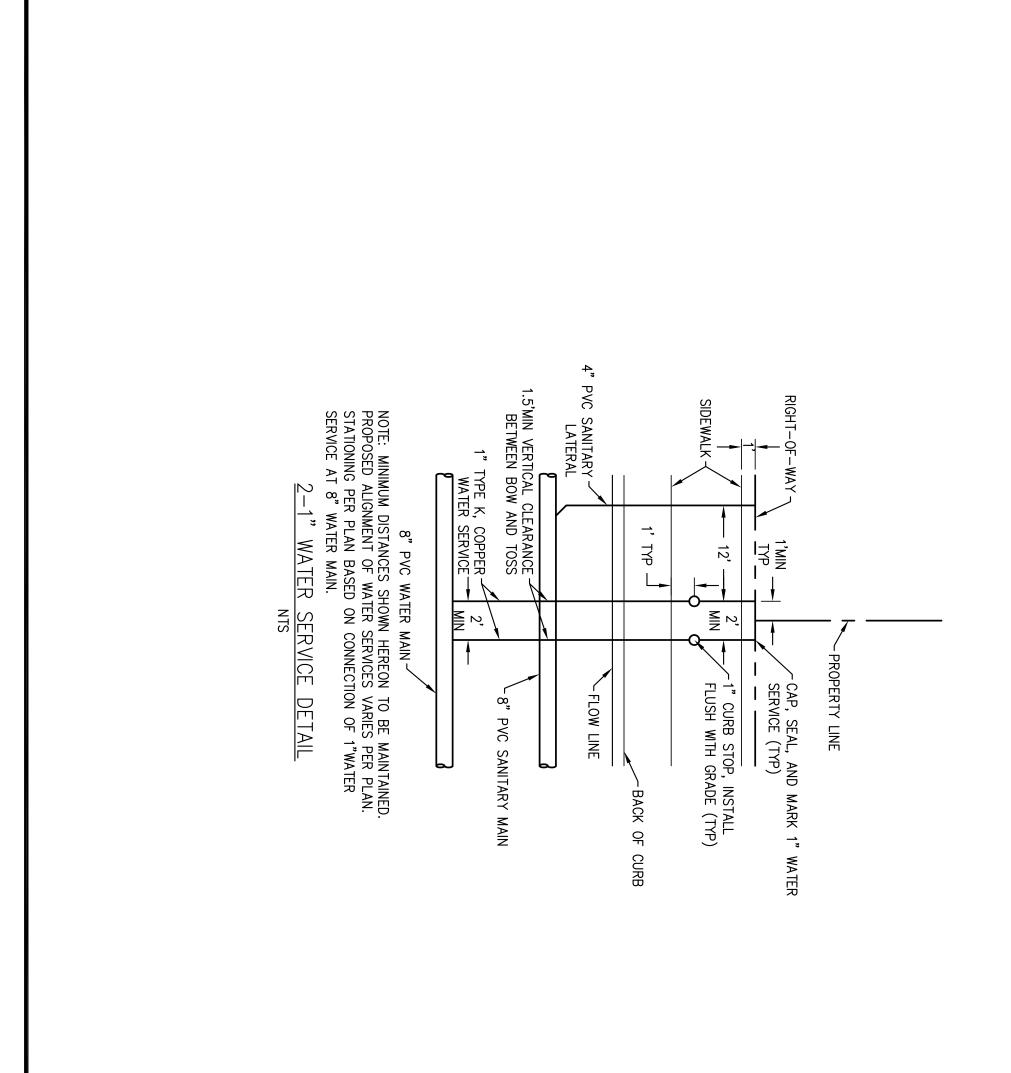

PREPARED UNDER THE SUPERVISION OF TAIT & ASSOCIATES, INC.

Registration Number PE-2610, on 07/14/15 and the original document is stored at the City of Mandan Administrative Office. This document originally issued and sealed by James Martin,

WATER & SANITARY SEWER DETAILS LAKEWOOD 8TH ADDITION AXIEN ENGINEERING MORTON COUNTY MANDAN, NORTH DAKOTA

TAIT Since 1964

2911 N 14th Street, Suite 301, Bismarck, ND 58501 p: 701/258/6397 www.tait.com f: 701/353/5798 NO. DESCRIPTION REVISIONS BY DATE

